46 O/A MODULAR GUARD BOOTH

(4' x 6' ACTUAL SIZE)

OHIO DESIGN CODES

2007 OHIO BUILDING CODE 2007 OHIO MECHANICAL CODE 2007 OHIO PLUMBING CODE 2005 NATIONAL ELECTRICAL CODE

DESIGN LIVE LOADS

FLOOR:	50 PSF LIVE LOAD 10 PSF DEAD LOAD
ROOF:	40 PSF LIVE LOAD 10 PSF DEAD LOAD

CONSTRUCTION TYPE:..... 5B OCCUPANCY/USE GROUP: B

BUILDING AREA: 24 SQ FT.

MINIMUM BUILDING

SET BACK:..... GREATER THAN 10 FEET TO A

COMMON OR ASSUMED PROPERTY LINE

SEISMIC ZONE: GROUP I, CATEGORY C MAXIMUM WIND LOAD: 90 MPH, EXPOSURE C

OCCUPANT LOAD: 1

PLAN B NOT USED

DRAWING NUMBER #1 SPECIFICATIONS #2 ELEVATIONS (GUARDHOUSE PLAN "A")(DOOR ON 4' SIDE) > #3 ELEVATIONS (GUARDHOUSE PLAN ""B")(DOOR ON 6' SIDE) #4 FLOOR / ELECTRICAL PLAN #5 CROSS SECTION / BLOCKING POINTS PLAN

DRAWING INDEX

SPECIAL LIMITATIONS:

ADEQUATE HANDICAPPED RESTROOM FACILITIES TO HANDLE THE ADDITIONAL OCCUPANT LOAD CREATED BY THE ADDITION OF THIS BUILDING TO A SITE SHALL BE PROVIDED IN AN ADJACENT BUILDING ON THE SAME PROPERTY. THE LOCAL OFFICIAL HAVING JURISDICTION SHALL VERIFY THE EXISTING FACILITIES.

ACCESSIBILITY EXCEPTIONS:

1103.2.7 Raised areas. Raised areas used primarily for purposes of security, life safty, or fire safety including, but not limited to, observation galleries, prison guard towers, fire towers, or life guard stands are not required to be accessible or to served by an accessible route.

1103.2.10 Single occupant structures. Single occupant structures accessed only by passageways below grade or elevated above grade including, but not limited to, toll booths that are accessed only by underground tunnels, are not required to be accessible Note: The single occupant guardhouses will be placed on and elevated entrance Island to the park that does not have an accessible route.

ON BOC	DRAWING N
DATE: 11/13/07	SCALE: NTS
TWIN MODULAR SERVICES, INC.	1001 LOWER LANDING RD, SUITE 607, BLACKWOOD, NJ 08012
DRAWN BY: R.M.	REV:
	ВООТН

08012

BLACKWOOD,

NC.

SERVICES

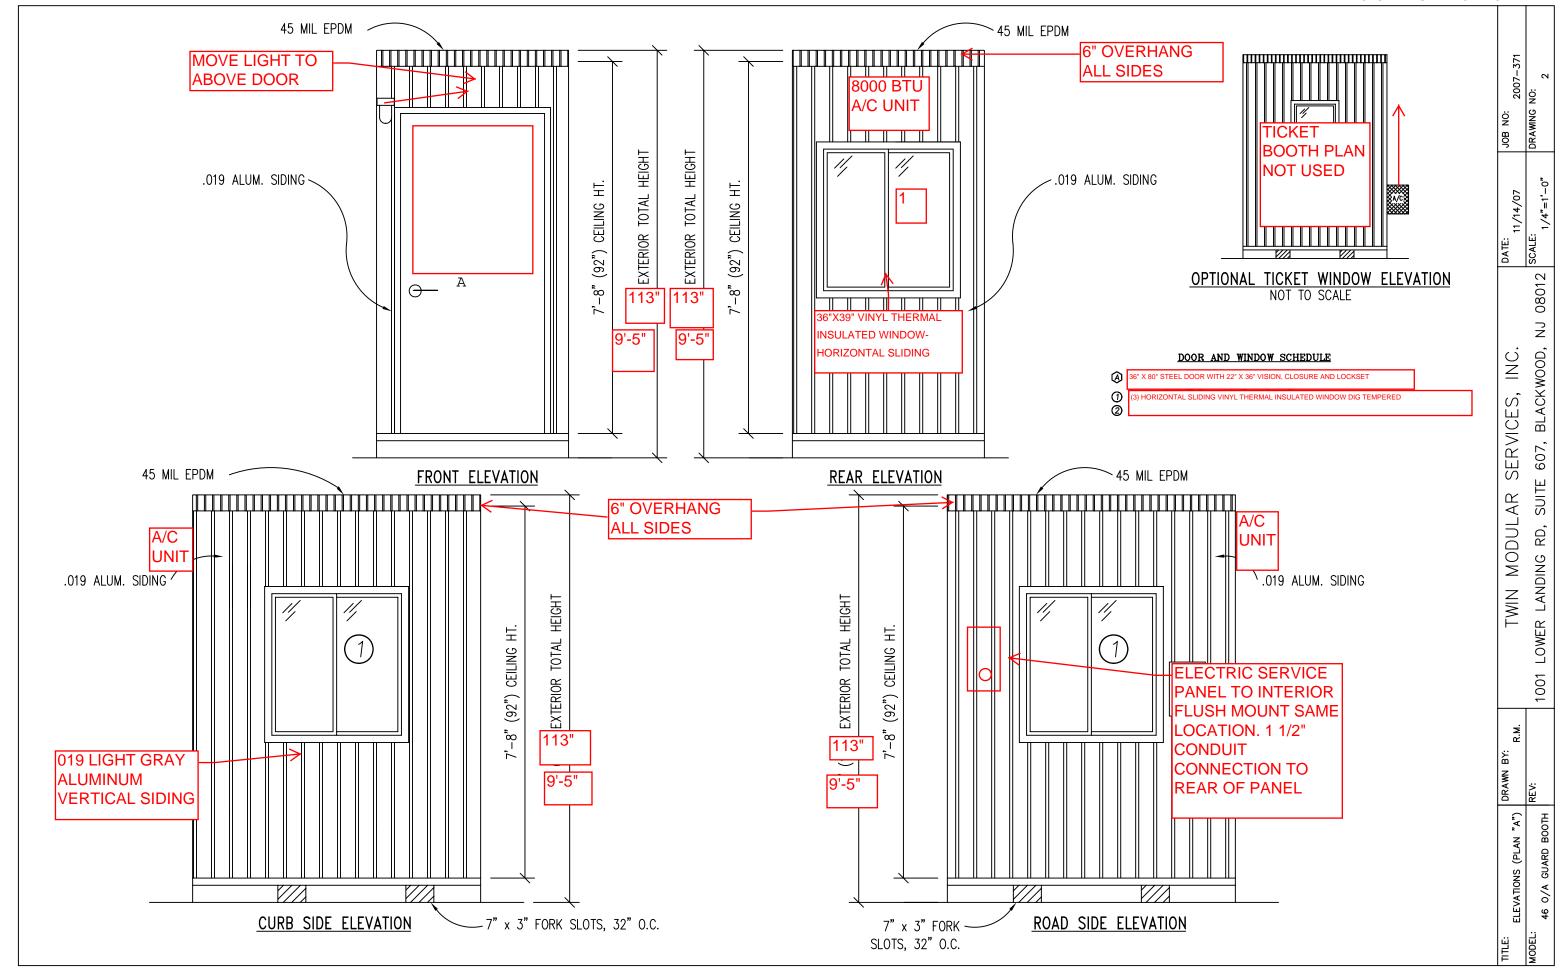
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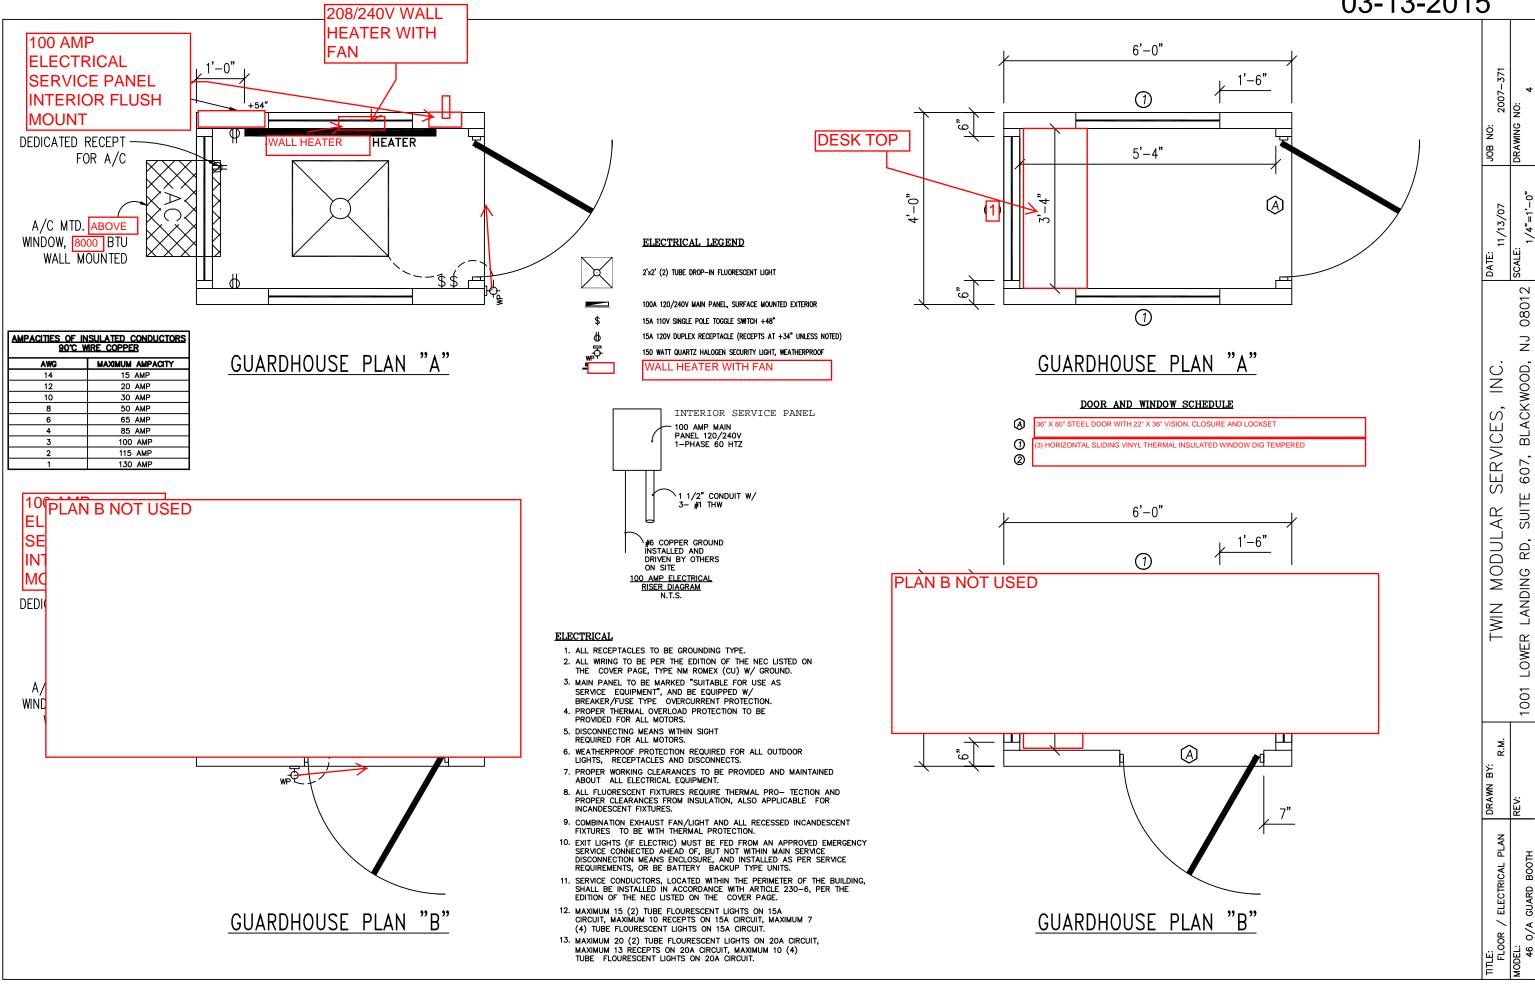
OPTION NOT ACCEPTED

CHASSIS TYPE: PERIMETER MAIN BEAM: 4" STEEL C CHANNEL 5.4 LBS PER FT CROSS MEMBERS: 4" STEEL C CHANNEL @ 24" OC PAINT: MARINE BASED EPOXY - BLACK **FLOOR** INSULATION: NONE DECKING: 3/4" PLYWOOD, 24 O.C. SECURED DIRECTLY TO STEEL FRAME OPTIONAL: 1/4" STEEL PLATE FLOOR W/ NON-SKIP EPOXY PAINT COVERING: 1/8" ALUMINUM TREAD PLATE FLOOR TRIM: 4" VINYL COVE BASE MOISTURE BARRIER: TYVEK OR EQUAL OPTIONAL:3/16" ALUMINUM DIAMOND PLATE FLOOR EXTERIOR WALLS STUDS: 2"x4" STUD GRADE SPF @ 16" O.C. BOTTOM PLATE: SINGLE 2"x4" #3 SPF TOP PLATE SINGLE 2"x4" #3 SPF WALL HEIGHT: 8'-3" FINISHED CEILING HT: 7'-8" A.F.F. INSULATION: R-13 FIBERGLASS KRAFT-BACKED BATTS INT. WALL COVERING: 1/4" VINYL COVERED PANEL (CLASS III) INT. WALL COVERING OPTION: 1/2" VINYL COVERED CYP. (CLASS I) **ROOF** TYPE: RAFTER, 2x4 #2 SPF @ 16" O.C. CEILING: 2'x4' T-GRID DROP CEILING @ 7'-9" A.F.F. INSULATION: R-13 KRAFT FACED FIBERGLASS BATTS 6" OVERHANG ALL SIDES OPTIONAL: 2"X8" BOW TYPE ROOF WITH R-30 INSULATION AND RIGID R-19 FLOOR INSULATION

ELECTRICAL MAIN DISTRIBUTION PANEL: INTERIOR (WEATHERPROOF) 100 AMP 120/240 VOLT SINGLE PHASE, 3 WIRE, 60 HZ. WITH GROUND RACEWAY: MINIMUM #14/2, 90 DEG. C. TYPE MC, COPPER INTERIOR LIGHTS: 2'x2' TWO TUBE LAY-IN FLUORESCENT TROFFER PER PRINT EXTERIOR LIGHTS: 150 WATT QUARTZ HALOGEN SECURITY LIGHT (WEATHERPROOF) SWITCHES: 120 V. 15 AMP SINGLE POLE PER PRINT RECEPTACLES: 120 V. 15 AMP DUPLEX RECEPTS PER PRINT OPTIONAL: ADDITIONAL 110V DUPLEX RECEPTS H.V.A.C. HEATING: 1500 WATT WALL MOUNT HEATER WITH FAN 208/240V DEDICATED CIRCUIT AIR CONDITIONING: 110V, 8000 BTU WALL MOUNT, DEDICATED CIRCUIT OPTION: THERMOSTAT CONTROL OF A/C & B.B. HEATER OPTION: 11600 BTU AIR CONTITIONING / HEAT COMBO UNIT, WALL MOUNTED EXTERIOR WINDOWS & DOORS DOORS: 36"x80" ALUM. DOOR, ALUM. FRAME, FOAM INSULATED W/ 14"x14" S.C., LEVER PASSAGE HARDWARE \square : 36"x80" STEEL DOOR W/22"X36" WINDOW (S.G.). CLOSER WINDOWS: 36"x39" HORIZONTAL SLIDER, ALUM. MILL FRAME, SINGLE GLAZE-36"X39" CLEAR TEMPERED CLASS HORIZONTAL SLIDER, ALUM. MILL FRAME (3) WINDOWS TOTAL OPTION:236"x39" HORIZONTAL SLIDER, VINYL THERMAL INSULATED WINDOWS < OPTION: 24"x36" CLEAR TEMPERED GLASS TICKET WINDOW WITH STAINLESS STEEL SHELF, SPEAK-THRU & 1/2 ROUND TICKET SERVICE OPTION: 136"x39" PICTURE WINDOW - NON OPERABLE, VINYL THERMAL INSULATED OR SINGLE GLAZED MILL FINISH FRAMES EXTERIOR FINISHES SIDING: .019 ALUMINUM LIGHT GRAY TRIM: .019 ALUMINUM DARK GRAY WALL SHEATHING: 7/16" OSB OR CDX PLYWOOD, 16/0 SPAN INDEX RATING ROOF SHEATHING: 1/2" CDX PLYWOOD, 16/0 SPAN RATING ROOF: .45 EPDM RUBBER ROOFING WINDOW AND DOOR TRIM: 3/4" X 2 1/2" VINYL - WHITE **FURNISHINGS** COUNTER TOP - WHITE MICA



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DRAWING

08012

BLACKWOOD,

607,

SUITE

LANDING

LOWER

1001

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SERVICES,

MODULAR

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BY:

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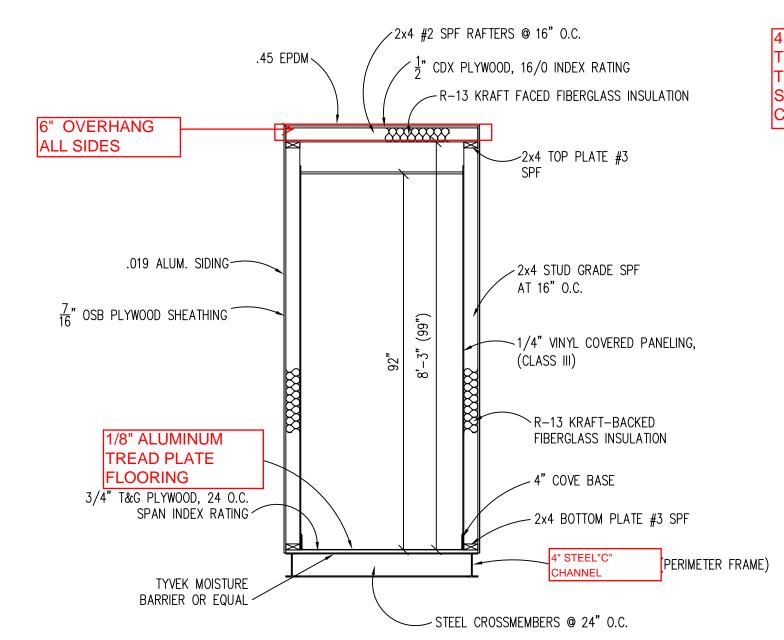
BLOCKING POINTS CROSS SECTION

TITLE:

GUARD

46

JOB



4 CONCRETE RED HEAD
TYPE ANCHORS
THROUGH 3/4" HOLE IN
STEEL "C" CHANNEL INTO
CONCRETE SLAB

+ 1.3K
1.3K
1.3K
1.3K
PERIMETER OF BLDG.

FOUNDATION AND TIE-DOWN DESIGN BY OTHERS

CONCRETE SLAB TYPE FOUNDATION 7'0" X 5'-0". TIE-DOWN WITH (4) CONCRETE WEDGE ANCHORS THROUGH STEEL "C" CHANNEL INTO CONCRETE. WEDGE ANCHORS ARE RED HEAD TYPE 1/2" X 4" #11285

FOUNDATION

- THE PIER LOCATIONS SHOWN ON THIS PLAN ARE FOR THE PURPOSE OF IDENTIFYING THE LOCATION OF THE REQUIRED BLOCKING POINTS AND THE LOADS APPLIED AT EACH POINT FOR THIS BUILDING. FOUNDATION REQUIREMENTS ARE NOT KNOWN DUE TO VARYING SOIL CONDITIONS.
- FOUNDATION DESIGN IS BY OTHERS. FOUNDATION REVIEW AND APPROVAL IS TO BE PERFORMED BY THE LOCAL OFFICIAL HAVING JURISDICTION.
- 3. CRAWL SPACE TO BE VENTILATED AT 1 SQ. FT. PER EACH 150 SQ. FT. OF CRAWL SPACE AREA TO BE VENTILATED.
- 4. PROVIDE POSITIVE DRAINAGE UNDER UNIT.
- 5. PROVIDE MINIMUM CRAWL SPACE ACCESS OF 22" x 24".
- 6. PIER LOADS ARE SHOWN IN KIPS

DESIGN LOADS

FLOOR LIVE LOAD = 50 PSF FLOOR DEAD LOAD = 10 PSF

ROOF LIVE LOAD = 40 PSFROOF DEAD LOAD = 10 PSF

EXTERIOR WALL
DEAD LOAD

D = 42 PLF

FOUNDATION LEGEND

+

INDICATES BLOCKING TO BOTTOM OF MAIN I-BEAM



INDICATES BLOCKING TO BOTTOM OF COLUMN



INDICATES MINUTE—MAN OR EQUAL FRAME TIE—DOWN LOCATION AND DIRECTION

BUILDING CODE

- 1. ATTIC VENTILATION SHALL NOT BE LESS THAN 1/150th OF THE HORIZONTAL AREA TO BE VENTILATED.
- THE BUILDING EXTERIOR AND ALL FACILITIES WITHIN THE BUILDING SHALL BE IDENTIFIED WITH THE INTERNATIONAL SYMBOL OF ACCESSIBILITY.
- 3. OWNER/BUYER SHALL BE RESPONSIBLE FOR ON SITE BARRIER FREE PROVISIONS: STEPS, RAMPS, PARKING SIGNS, ETC. BUILDING APPROACH (WALK OR RAMP) WITH A MINIMUM WIDTH OF 5' AND A GRADIENT OF NOT MORE THAN 1 FOOT IN 20 FEET.
- 4. ALL LOCKS TO BE UNLOCKABLE FROM THE INTERIOR WITHOUT THE USE OF A KEY OR SPECIAL KNOWLEDGE.
- CORROSION RESISTANT FLASHING AT TOP AND SIDES OF DOORS, WINDOWS AND AT ROOF PENETRATIONS.
- ALL GLAZING WITHIN 24" OF EXTERIOR PASSAGE DOORS AND IN PASSAGE DOORS, OR WITHIN 18" OF FLOOR TO BE "SAFETY GLAZED" AND SO MARKED.